
# DEPARTMENT OF WORK FORCE SERVICES REPLACEMENT OF CONCRETE STAIRS AND RAMP

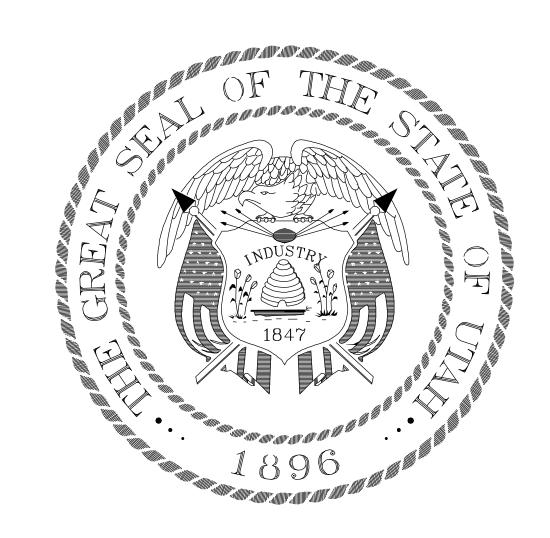

State of Utah-Department of Administrative Services

4110 State Office Building/Salt Lake City, Utah 84114/538-3018

PROJECT INFORMATION		SHEET INDEX	CODE ANALYSIS
OWNER:	DIVISION OF FACILITIES CONSTRUCTION AND MANAGEMENT STATE OF UTAH  DEPARTMENT OF WORK FORCE SERVICES CEDAR CITY, UTAH	ARCHITECTURAL  GI. OO COVER SHEET  A2. OI FLOOR PLAN - EXISTING A2. O2 FLOOR PLAN - DEMOLITION A2. O3 DEMOLITION PHOTOS A2. O4 DEMOLITION PHOTOS A2. O5 DEMOLITION PHOTOS A2. IO FLOOR PLAN - NEW CONSTRUCTION	APPLICABLE CODES
			Year Year
			International Building Code 2006 National Electrical Code 20 International Mechanical Code 2003 Uniform Code for International Plumbing Code 2003 Building Conservation 199
PROJECT TITLE:	REPLACEMENT OF FRONT STAIRS AND RAMP	A2.05 DEMOLITION PHOTOS A2.10 FLOOR PLAN - NEW CONSTRUCTION A2.11 DETAILS	International Fire Code 2003 ADA Accessibility
		AZZZZZZZZZZZZZZZZZZZZZZZZZZZZZZZZZZZZZ	International Energy Guildelines 2006
PROJECT NUMBER:	07282920		A COCUPANOV AND CROUP
			A. OCCUPANCY AND GROUP: B  CHANGE IN USE: NO
			MIXED OCCUPANCY: NO
			SPECIAL USE AND OCCUPANCY: NO
			B. SEISMIC DESIGN CATEGORY: ID
			DESIGN WIND SPEED: 90 MPH EXPOSURE D
			C. TYPE OF CONSTRUCTION: VB
			D. FIRE RESISTANCE RATING REQUIREMENTS FOR EXTERIOR WALLS BASED ON THE FIRE SEPARATION DISTANCE (IN HOURS))
			EXTERIOR WORK  E. MIXED OCCUPANCIES: N/A
			NONSEPARATED USES: N/A
			F. SPRINKLERS: N/A
			G. NUMBER OF STORIES: N/A
			H. ACTUAL AREA PER FLOOR: N/A
			I. TABULAR AREA: N/A
			J. AREA MODIFICATION: N/A
			K. FIRE RESISTANCE RATING REQUIREMENTS FOR BUILDING ELEMENTS (HOURS): N/A
			L. DESIGN OCCUPANT LOAD: N/A
			M. MINIMUM NUMBER OF REQUIRED PLUMBING FACILITIES: N/A
			FOOTNOTES:  I) IN CASE OF CONFLICT WITH THE U.S. DEPARTMENT O JUSTICE FEDERAL REGISTERS, ADA GUIDELINES AND SPECIFIC REFERENCE TO THE INTERNATIONAL BUILDING CODE ACCESSIBILITY CHAPTERS, THE MORE RESTRICTIVE REQUIREMENTS SHALL GOVERN.

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Sheet Title:


Revisions: ⚠ DFCM REVIEW 10.8.01

PROJECT NUMBER: 07485 DRAWN BY: CHECKED BY:

J.C.S. J.C.S. APPROVED BY:

09.10.07



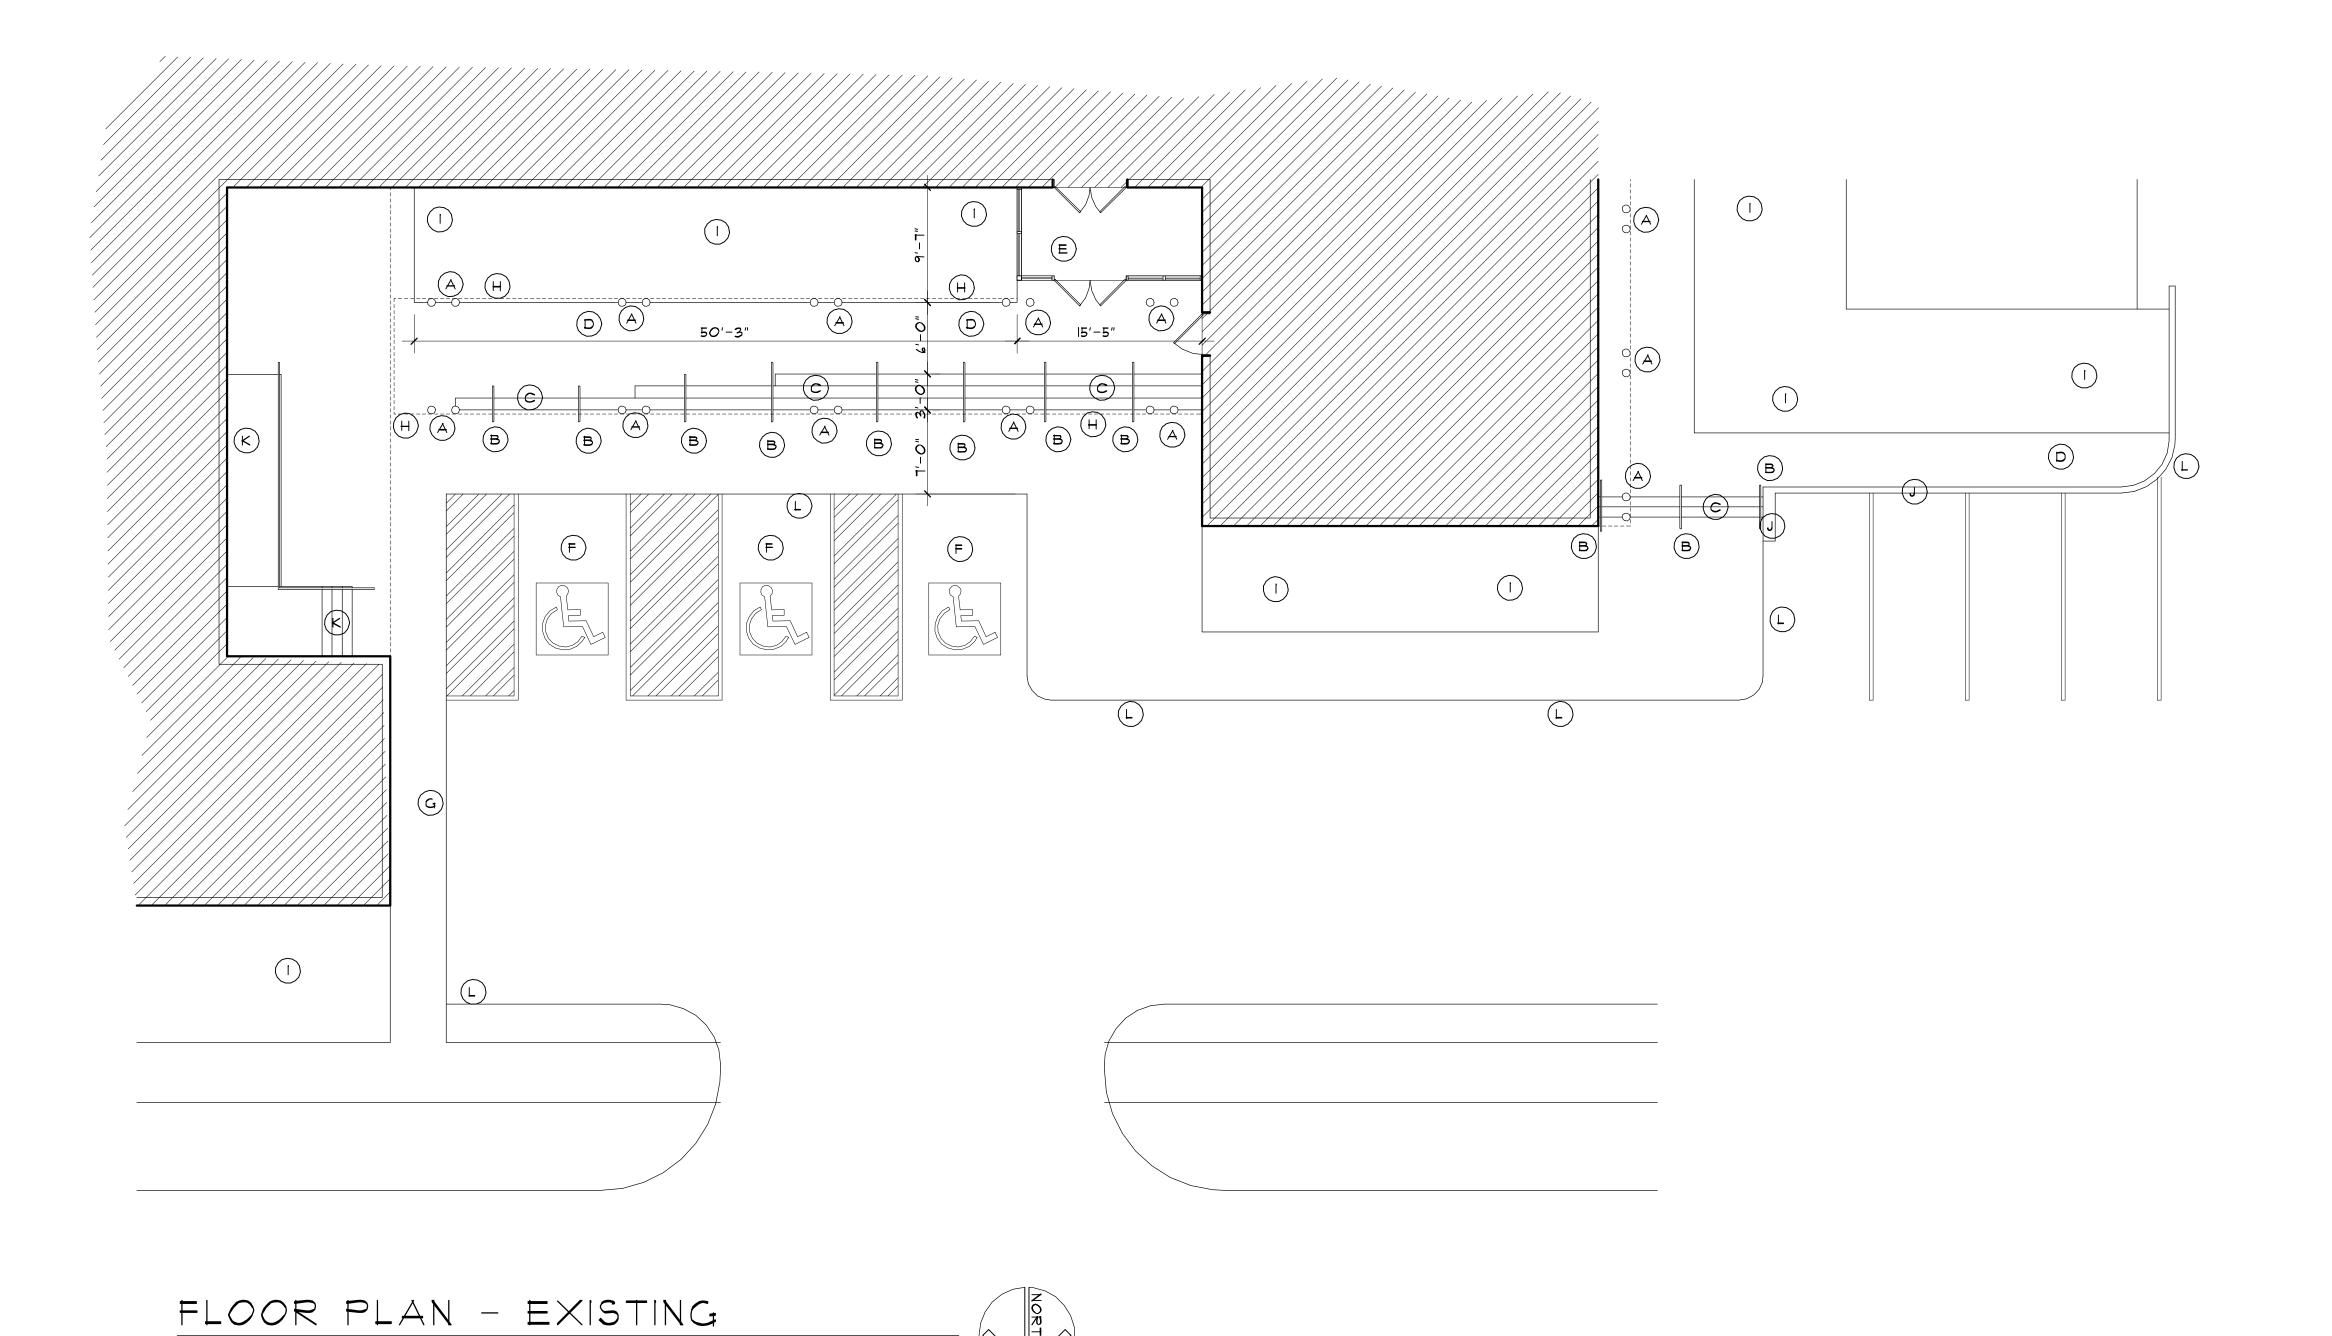


SCALE: 1/8"=1'-0"

KEY NOTES DESIGN GROUP
ARCHITECTURE | PLANNING KEY NOTE MARK EXISTING COLUMNS
EXISTING HANDRAIL
EXISTING CONCRETE STEPS
EXISTING CONCRETE RAMP
EXISTING ENTRY
VESTIBULE
F EXISTING ACCESSIBLE
PARKING
G EXISTING SIDEWALK ASSCESS
H EDGE OF EXISTING CANOPY
I EXISTING LANDSCAPING
J EXISTING RETAINING WALL
K EXISTING STAIRS, RAMP AND
HANDRAIL NOT PART OF
CONTRACT
L EXISTING CURB AND GUTTER 2390 WEST HIGHWAY 56 SUITE 4A CEDAR CITY, UTAH 84720 OFFICE: (435) 586-8510 FAX: (435) 586-4873 E Z SARG

GENERAL NOTES:

I. GENERAL CONTRACTOR TO VERIFY EXISTING CONDITIONS AND DIMENSIONS.

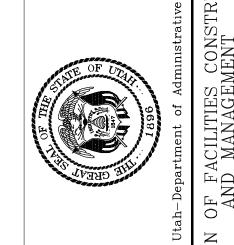


MORKFORON CHUAR CITY

Sheet Title:

FLOOR PLAN EXISTING

Revisions:

PROJECT NUMBER: 07485 09.10.07 DRAWN BY: J.C.S. CHECKED BY: J.C.S. APPROVED BY: J.C.S.

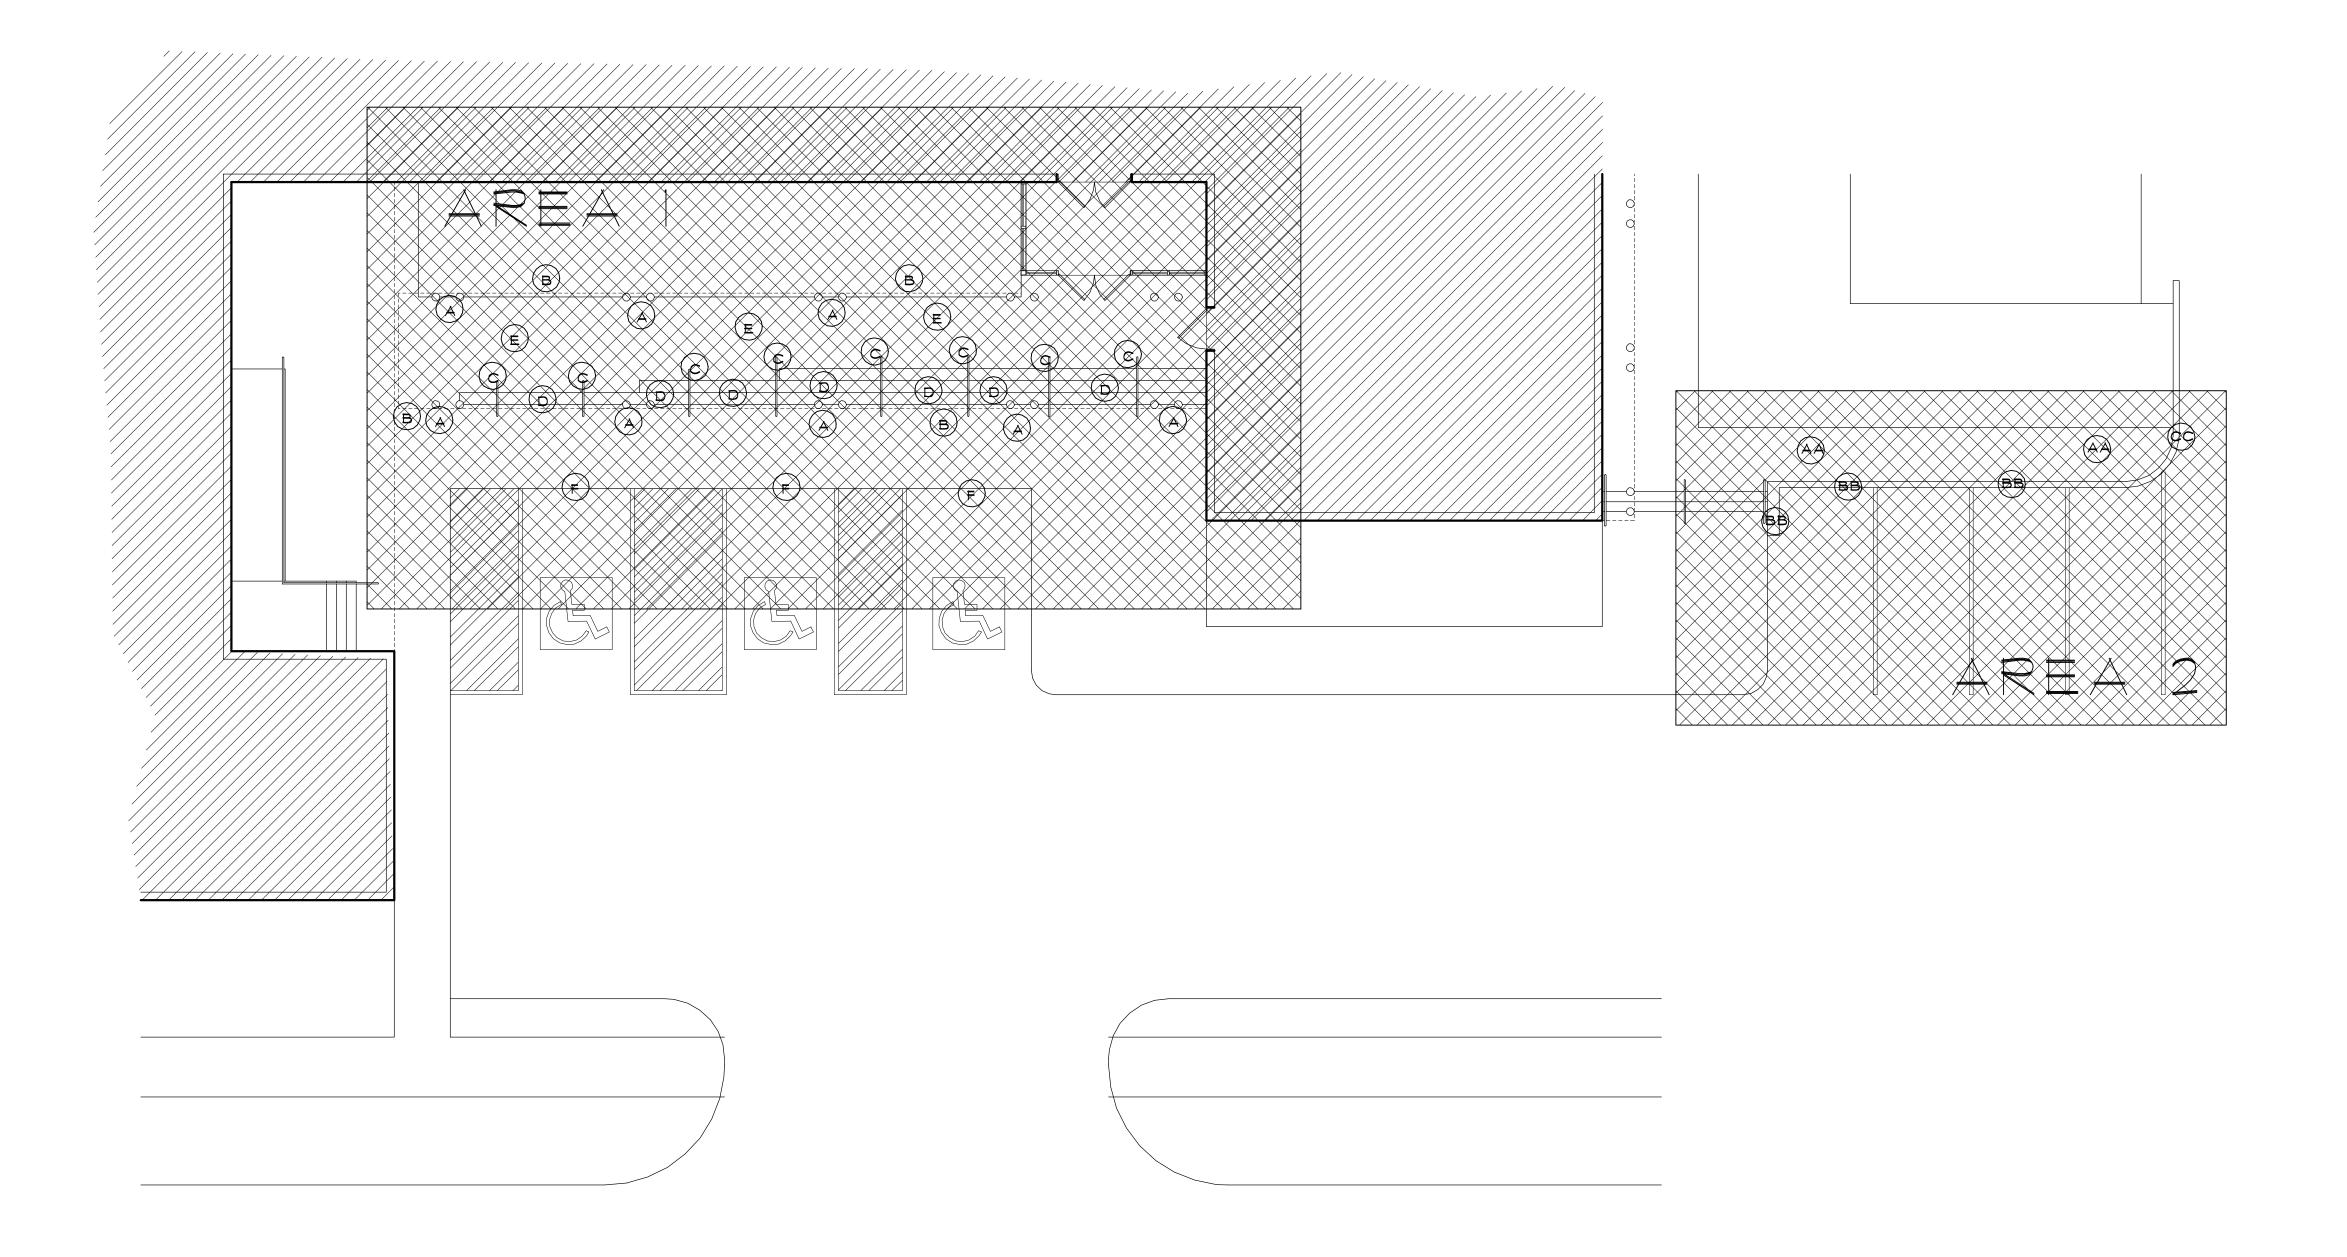

FLOOR PLAN - DEMOLITION

SCALE: 1/8"=1'-0"



### KEY NOTES

KEY NOTE MARK



AREA INCLUDED IN CONTRACT

AREA I PRIMARY AREA

OF CONTRACT AREA 2 ADD ALTERNATE AREA

### AREA I

EXISTING COLUMNGS TO BE REMOVED EXISTING CANOPY TO BE REMOVED EXISTING HANDRAILS TO BE EXISTING STAIRS TO BE REMOVED EXISTING RAMP TO BE

REMOVED
EXISTING CURB AND GUTTER
TO BE REMOVED


### AREA 2

AA EXISTING RAMP TO BE
REMOVED
BB EXISTING RETAINING WALL
TO BE REMOVED
CC EXISTING CURB AND GUTTER
TO BE REMOVED

### GENERAL NOTES:

GENERAL NOTES:

1. CONTRACTOR TO VERIFY
EXISTING CONDITIONS AND
DIMENSIONS.
2. ALL DEBRIS TO BE TAKEN
TO AN APPROVED LANDFILL.
3. CONTRACTOR TO PROVIDE
BARRIERS AS NEEDED TO
PROTECT THE OCCUPANTS OF THE
BUILDING DURING DEMOLITION
AND CONSTRUCTION.
4. CONTRACTOR TO PROTECT
EXISTING SURFACES AND
MATERIALS FROM DAMAGE DURING
DEMOLITION AND CONSTRUCTION.
5. IF REQUIRED DUST BARRIERS
SHALL BE CONSTRUCTED TO
PREVENT DUST FROM GETTING INTO
THE BUILDING.
6. WHEN REQUIRED EXISTING
STRUCTURES SHALL BE BRACED
AS NEEDED.
1. ALL DAMAGE TO EXISTING
STRUCTURES AND MATERIALS
SHALL BE REPAIRED USING
EQUAL OR BETTER MATERIALS
SHALL BE REPAIRED USING
EQUAL OR BETTER MATERIALS
8. ANY ELECTRICAL, WATER
OTHER EXISTING UTILITIES
UNCOVERED OR DAMAGED DURING
DEMOLITION AND
CONSTRUCTION THAT ARE
DETERMINED TO BE ABANDONED
CONTRACTOR SHALL KEEP AN
AS-BUILT SET OF DRAWINGS
FOR OWNER'S REFERENCE.
10. CONTRACTOR SHALL KEEP AN
AS-BUILT SET OF DRAWINGS AS REQUIRED
DURING DEMOLITION AND
CONSTRUCTION.

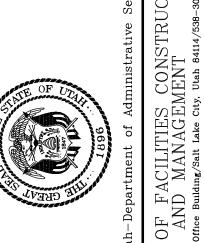

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2390 WEST HIGHWAY 56 SUITE 4A CEDAR CITY, UTAH 84720 OFFICE: (435) 586-8510 FAX: (435) 586-4873

MORKFOROE CHUAR CITY

Sheet Title:


FLOOR PLAN DEMOLITION


Revisions:

PROJECT NUMBER: 07485 09.10.07 DRAWN BY: J.C.S. J.C.S. CHECKED BY: APPROVED BY: J.C.S.





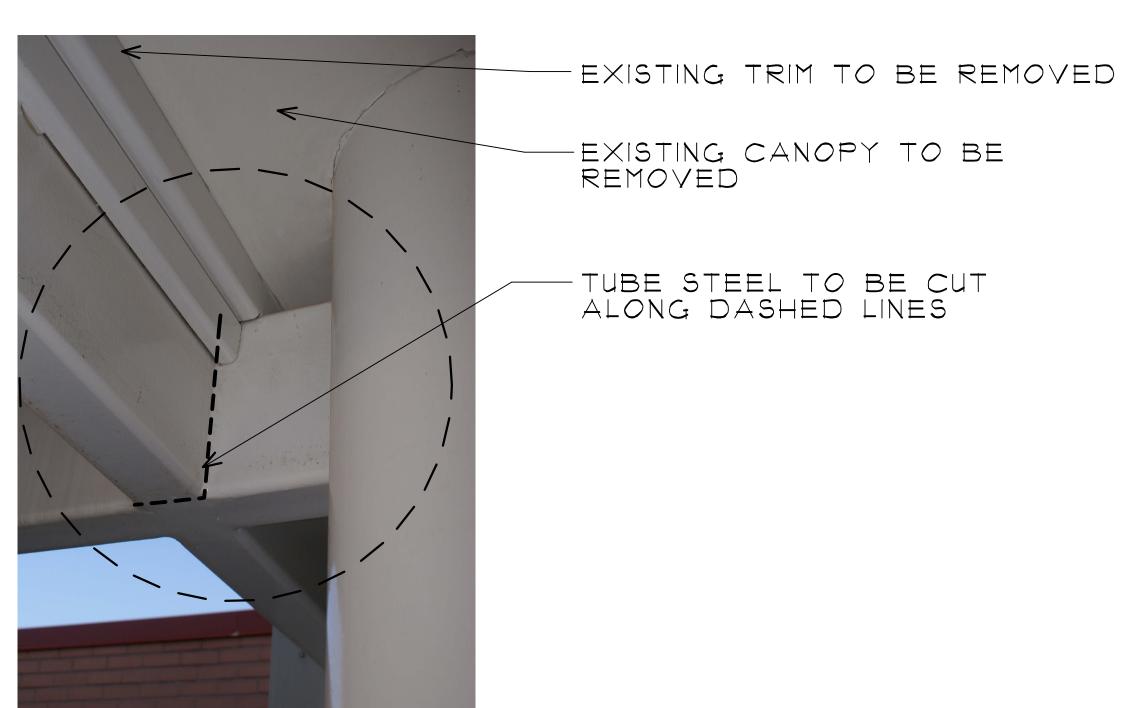

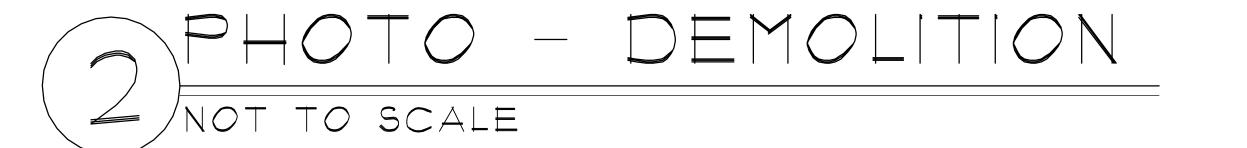

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2390 WEST HIGHW
SUITE 4A
CEDAR CITY, UTA

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artment of Administrative Services
ACILITIES CONSTRUCTIO
MANAGEMENT

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Sheet Title:

DEMOLITION PHOTOS

Revisions:

PROJECT NUMBER: 01485

DATE: 09.10.01

DRAWN BY: J.C.S.

CHECKED BY: J.C.S.

APPROVED BY: J.C.S.

A2.03

SHEET NUMBER: Sheet of

MORKFORCE CHUAR CITY,

Sheet Title:

DEMOLITION PHOTOS

Revisions:

PROJECT NUMBER: 07485 09.10.07 DRAWN BY: J.C.S. J.C.S. CHECKED BY: APPROVED BY:

A2.04


SHEET NUMBER:



TUBE STEEL TO BE CUT AT LINE, EXISTING COLUMN TO BE CUT AT LINE, ALL EXPOSED VOIDS IN COLUMN AND TUBE STEEL TO BE PATCHED WITH STEEL PLATE SAME THICKNESS AS COLUMN AND TUBE STEEL, ALL JOINTS TO BE GROUND, PRIMED AND PAINTED TO MATCH EXISTING

-EXISTING ROOF OVER ENTRY Vestibule to remain, new fascia trim after canopy is removed

# PHOTO - DEMOLITION NOT TO SCALE

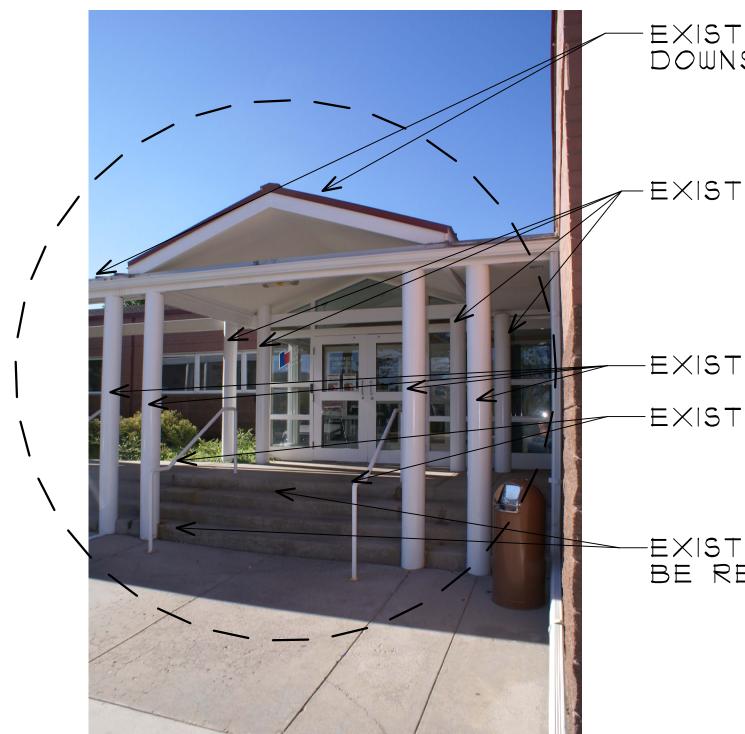

EXISTING CANOPY, GUTTER AND DOWNSPOUTS TO BE REMOVED

-EXISTING COLUMNS TO REMAIN

-EXISTING COLUMNS TO BE REMOVED -EXISTING HANDRAILS TO BE REMOVED

-EXISTING CONCRETE STEPS TO BE REMOVED

PHOTO - DEMOLITION NOT TO SCALE

-EXISTING CANOPY TO BE REMOVED

-EXISTING COLUMNS TO BE REMOVED

EXISTING HANDRAIL TO BE REMOVED

-EXISTING CONCRETE STEPS TO BE REMOVED

-EXISTING


HANDRAIL TO REMAIN

## PHOTO - DEMOLITION NOT TO SCALE




EXISTING HANDRAIL TO -REMAIN

EXISTING COLUMNS TO-REMAIN

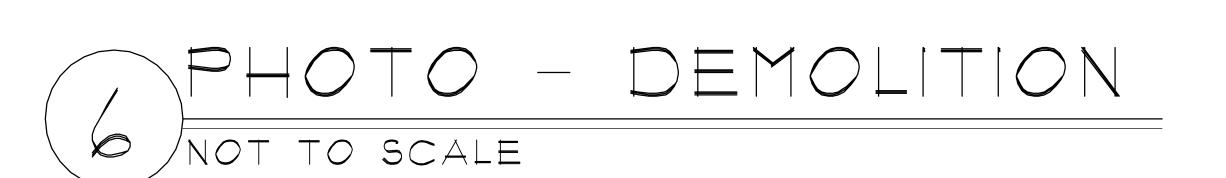

SARGENT DESIGN GROUP

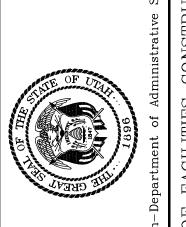

MORKFORCE CHUAR CITY


Sheet Title:

DEMOLITION PHOTOS

Revisions:


PROJECT NUMBER: 07485 09.10.07 DRAWN BY: J.C.S. CHECKED BY: J.C.S. J.C.S. APPROVED BY:

A2.05

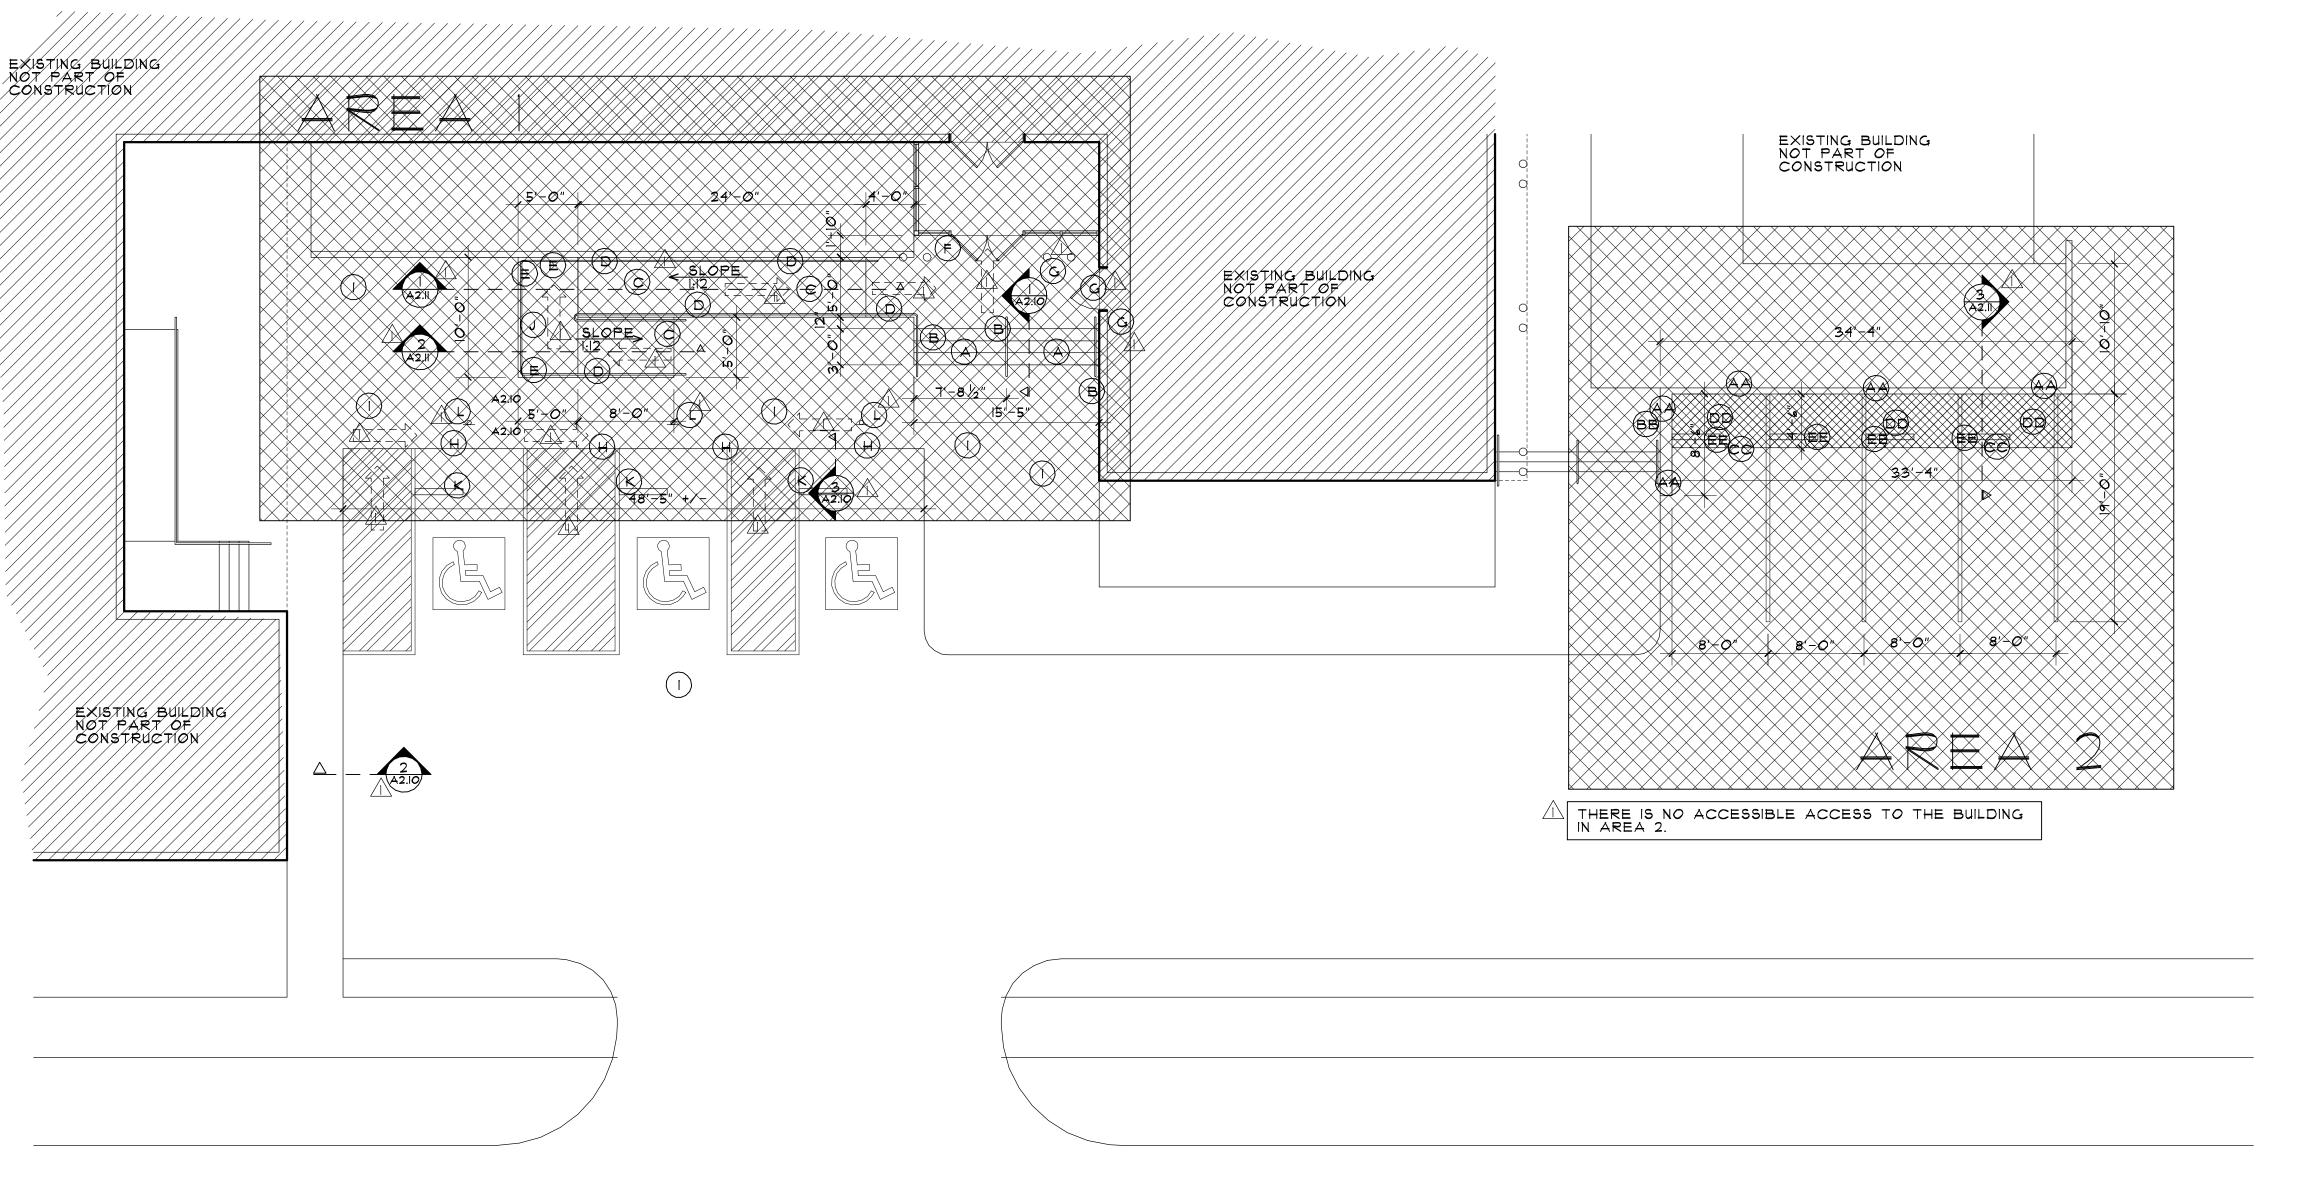


### FLOOR PLAN - NEW CONSTRUCTION


SCALE: 1/8"=1'-0"

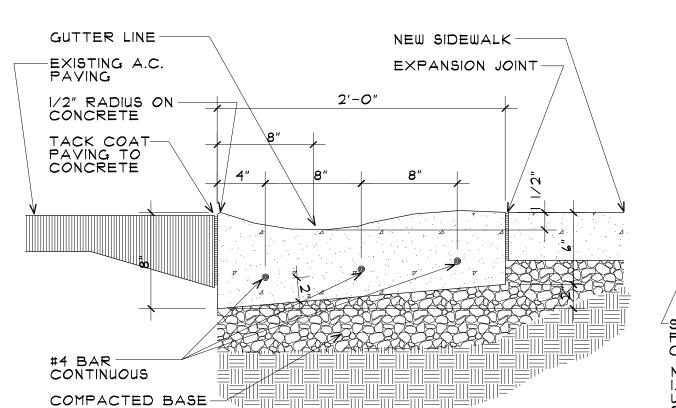

DETAIL NOT TO SCALE

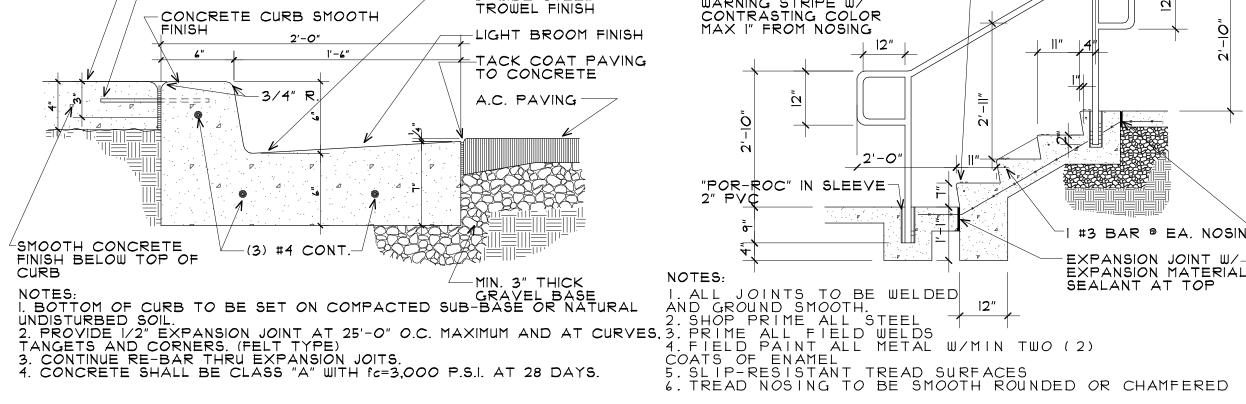

/NOT TO SCALE

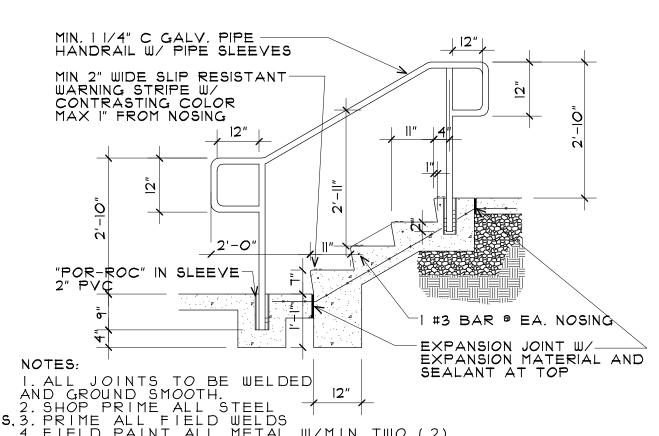

DETAIL

### KEY NOTES

KEY NOTE MARK



AREA

AREA INCLUDED IN CONTRACT

AREA I PRIMARY AREA OF CONTRACT

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### AREA 2 ADD ALTERNATE

NEW CONCRETE STEPS SEE DETAIL 1/A2.10 NEW HANDRAIL, SEE DETAIL

NEW CONCRETE RAMP CROSS SLOPE TO BE 1:48 RAMP SLOPE TO BE 1: 12 MAX NEW HANDRAIL

NEW HANDRAIL
NEW GUARDRAIL
NEW FASCIA AT ENTRY
VESTIBULE, AS REQUIRED
NEW POWER ASSIST OPERATOR
FOR EXISTING DOOR INTO
CONFERENCE ROOM, PROVIDE
ACTIVATION BUTTON ON
EXTERIOR COLUMN AND ON
INTERIOR WALL NEXT TO
DOOR, PROVIDE ALL
REQUIRED WIRING, CONDUIT
AND CONNECTIONS TO POWER
SOURCE.

SOURCE, NO CURB GUTTER NEW CONCRETE SIDEWALK NEW RAMP LANDING NEW WHEEL STOP NEW ACCESSIBLE PARKING STALL SIGNAGE

### AREA 2

AA NEW RETAINING WALL BB NEW GUARDRAIL
CC LINE OF EXISTING ASPHALT
DD NEW CONCRETE PAVING
EE NEW WHEEL STOP

### LACCESSIBLE ROUTE \_\_\_\_\_\_

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GENERAL NOTES: I. NEW STEPS AND RAMP TO MEET ALL GOVERNING ADA GUIDELINES.
2. CONTRACTOR TO VERIFY EXISTING CONDITIONS AND EXISTING CONDITIONS AND DIMENSIONS.

3. NEW FASCIA FOR ENTRY VESTIBULE TO MATCH EXISTING METAL FASCIA AND ROOFING.

4. NEW FASCIA TRIM TO MATCH EXISTING.

5. ALL NEW MATERIALS TO BE PAINTED TO MATCH EXISTING AS REQUIRED REQUIRED.

6. WHERE REQUIRED PLATE USED TO PATCH TUBE STEEL TO BE WELDED AND EDGES GROUND SMOOTH AND PAINTED AS REQUIRED.

1. NEW CONCRETE STEPS TO BE INSTALLED PER GOVERNING STANDARDS AND GUIDELINES.

8. NEW CONCRETE RAMP TO BE INSTALLED PER GOVERNING STANDARDS AND GUIDELINES.

9. NEW RETAINING WALLS TO BE INSTALLED PER GOVERNING STANDARDS AND GUIDELINES.

10. NEW RETAINING WALLS TO BE INSTALLED PER GOVERNING STANDARDS AND GUIDELINES.

10. NEW POWER ASSIST ACCESSIBLE HARDWARE FOR THE EXISTING DOOR TO THE CONFERENCE ROOM TO BE INSTALLED PER MANUFACTURER'S GUIDELINES.

CONTRACTOR TO PROVIDE ALL REQUIRED ACCESSORIES AND ELECTRICAL POWER.

11. DAMAGE CAUSED DURING CONSTRUCTION TO BE REPAIRED AND MATCH EXISTING COLORS AND MATERIALS. REQUIRED.

CONSTRUCTION TO BE REPAIRED

AND MATCH EXISTING COLORS AND

MATERIALS.

12. AT NO CURB GUTTER NEW

SIDEWALK TO SLOPE AS REQUIRED

TO MEET GOVERNING STANDARDS

AND GUIDELINES.

13. ALL NEW CONCRETE SURFACES

TO BE SLOPED AS REQUIRED AND

TO BLEND WITH EXISTING

CONCRETE SURFACES TO REMAIN.

14. ALL WORK TO BE PERFORMED

IN ACCORDANCE WITH THE STATE

OF UTAH, DFCM STANDARDS.

15. CONCRETE 
A. USE UNTREATED BASE COURSE

UNDER ALL CURBS AND GUTTER.

USE UNTREATED BASE COURSE

MATERIAL UNDER ALL SIDEWALKS

EXTERIOR FLATWORK AND

PAVED AREAS.

B. MINIMUM 6" COMPACTED BASE

(94.%) OD MATERIAL COMPACTED BASE

EXTERIOR FLATWORK AND
PAVED AREAS.
B. MINIMUM 6" COMPACTED BASE
(96%) OR MINIMUM 4 3/4"
CRUSHED GRAVEL.

16. PARKING LOT A. STRIPING PAINT: STATE OF
UTAH #180. SPREAD AT THE
RATE OF 103-113 SF/GAL. MINIMUM THICKNESS SHALL BE
1 DRY MIL.
B. SURFACE SMOOTHNESS:
VARIATION IN THE FINISHED
SURFACE MUST NOT EXCEED
1/8" IN 10 FT. IN ANY DIRECTION.
C. DRAINAGE: SLOPE ALL
ASPHALT CONCRETE PAVING
SURFACES FOR POSITIVE
DRAINAGE A MINIMUM OF 1.5%
AND PREFERABLE 2%.

MO5 30 | Sheet Title:


CONSTRUCTION


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Revisions: DFCM REVIEW 10.8.01

PROJECT NUMBER: 01485 09.10.07


DRAWN BY: J.C.S. J.C.S. CHECKED BY: APPROVED BY: J.C.S.




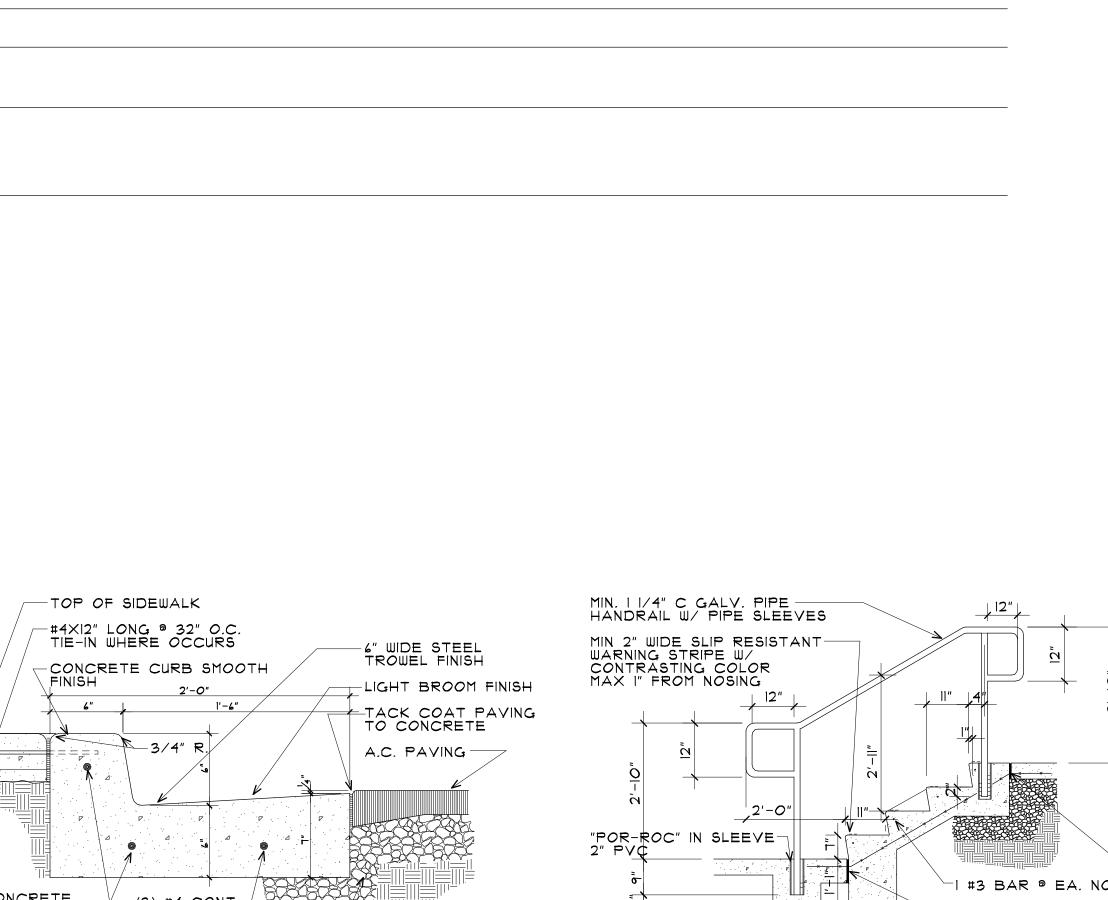

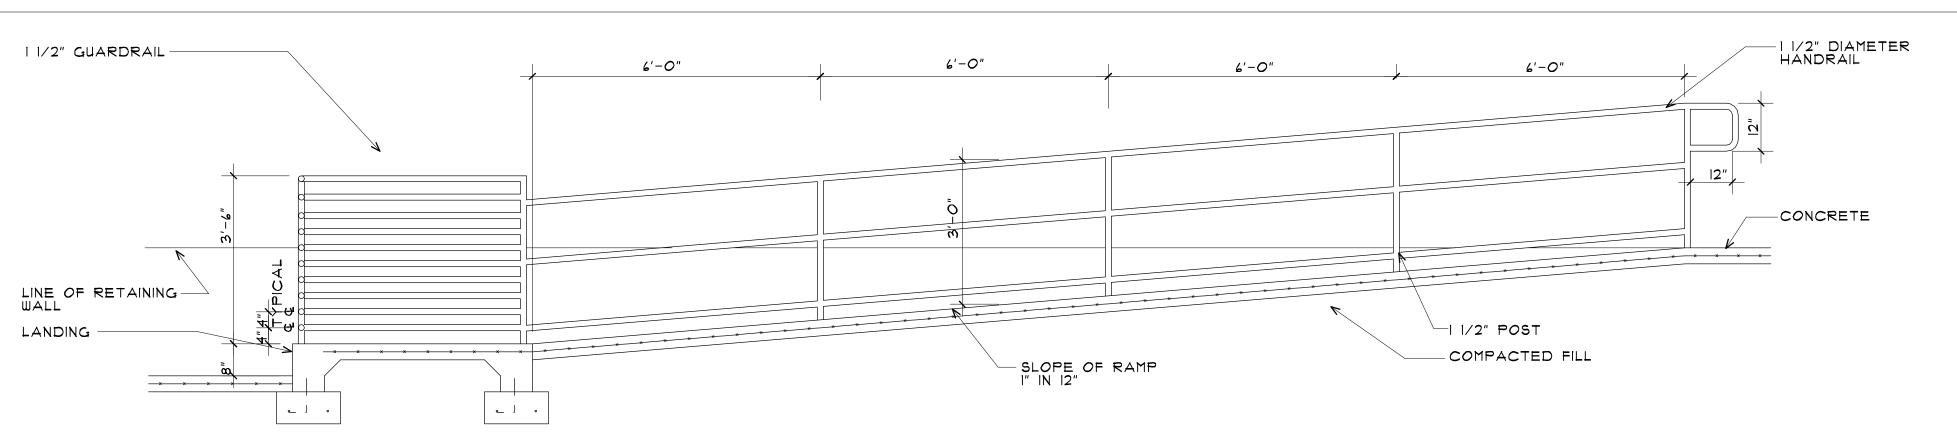
### ADA DOOR HARDWARE NOT TO SCALE



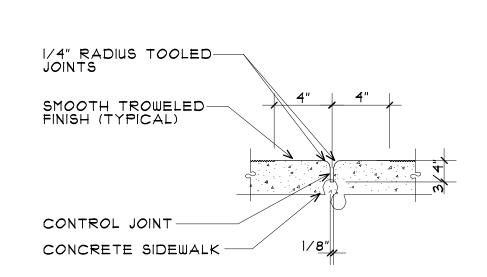

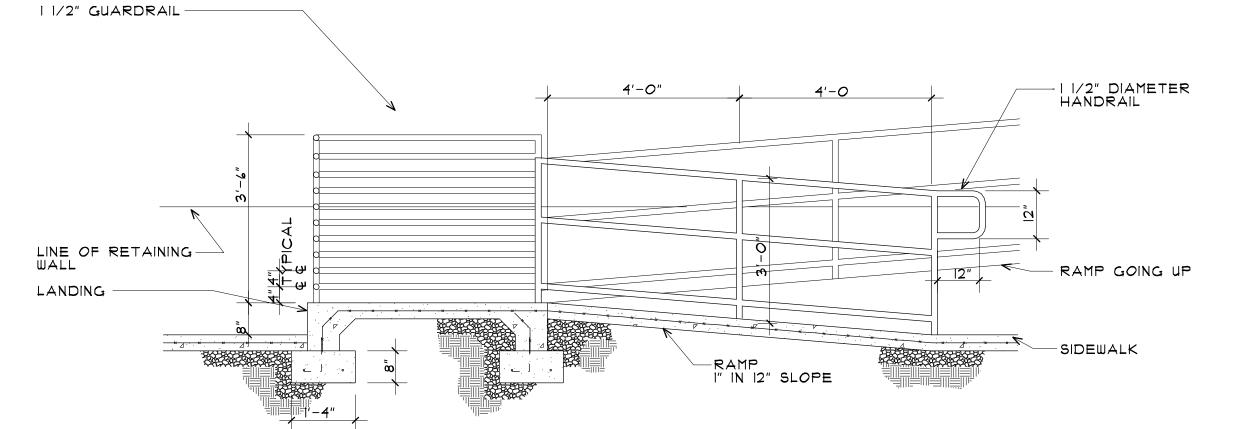

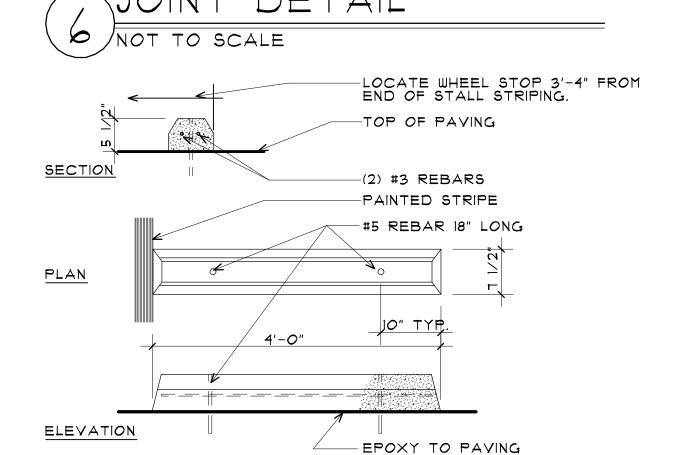

STOP

- EXISTING DOOR WHERE POWER ASSIST HARDWARE WILL BE ADDED


-LOCATION OF EXTERIOR ACTIVATING BUTTON FOR POWER ASSIST HARDWARE

CONTRACTOR TO PROVIDE APPROVED SIGNAGE INDICATING THAT THE EXISTING DOOR HAS POWER ASSIST HARDWARE


WHEEL


NOT TO SCALE



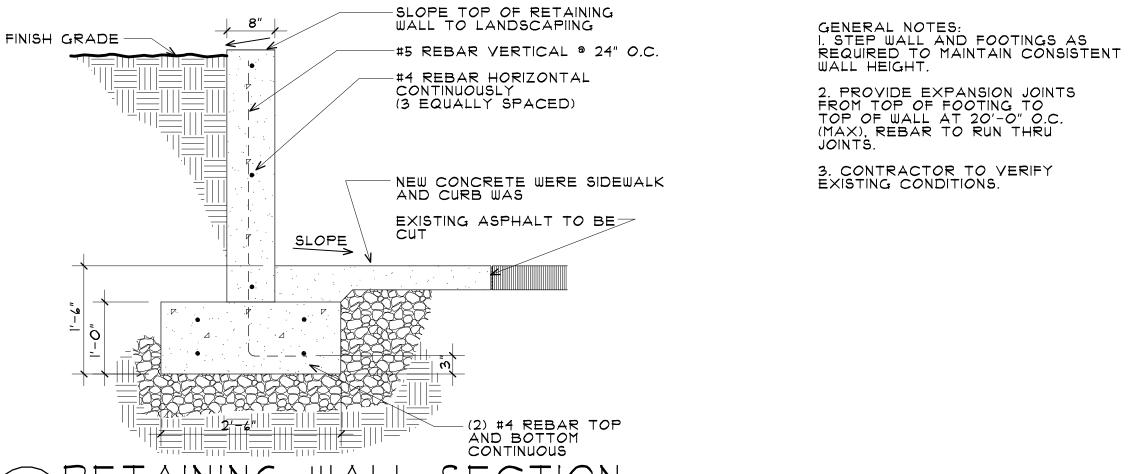

# SCALE: 3/4"=1'-0"

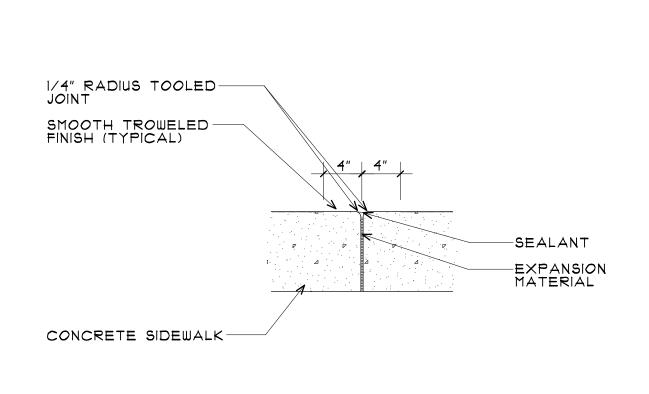

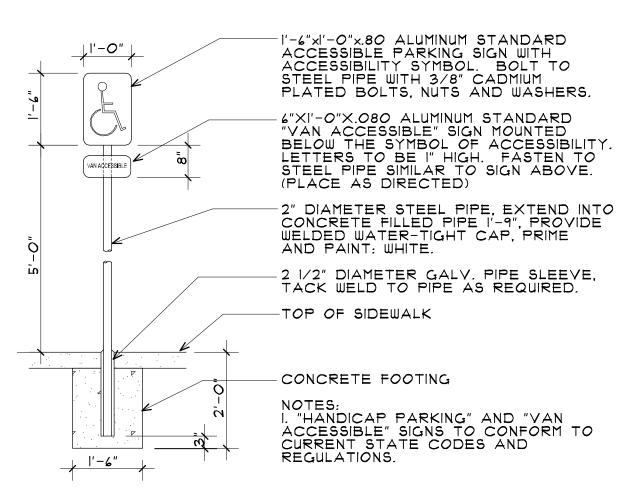



5 JOINT L DETAIL NOT TO SCALE

SIGNAGE NOT TO SCALE

SHEET NUMBER: ALL NEW SHEET

 $\Omega$ Project:

Sheet Title: DETAILS

Revisions:

PROJECT NUMBER: 01485 DATE: 09.10.07 DRAWN BY: J.C.S. J.C.S. CHECKED BY:

DESIGN GROUP
ARCHITECTURE | PLANNING

SARGENT

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A DFCM REVIEW 10.8.01

J.C.S. APPROVED BY: